

NEW MASTER FLOW 17.5" x 9.25"
 PLASTIC FOUNDATION VENT MODEL FVRABL.
 REMOVE SILL PLATE AS REQUIRED
 TO INSTALL. (4) TOTAL AT CORNERS


FOUNDATION PLAN
 1/4" = 1'-0"

F1: EXISTING FOOTING TO REMAIN


F2: NEW 2' x 2' x 8" FOOTING WITH (4) #3 BARS EACH WAY 3" CLEAR TO BOTTOM. CENTER BETWEEN EXISTING FOOTINGS. DIG MINIMUM OF 1" INTO CRAWL SPACE FLOOR OR TO SUITABLE SOILS.


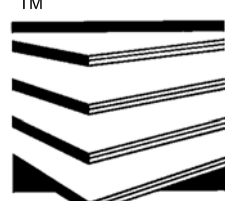
HOME SLOPES DOWN TO THE NORTH. SET NEW BEAM AND JACK FLOORS TO MATCH AVERAGE ELEVATION OF FOUNDATION WALLS TO THE EAST AND WEST.

VERIFY ALL DIMENSIONS IN THE FIELD.

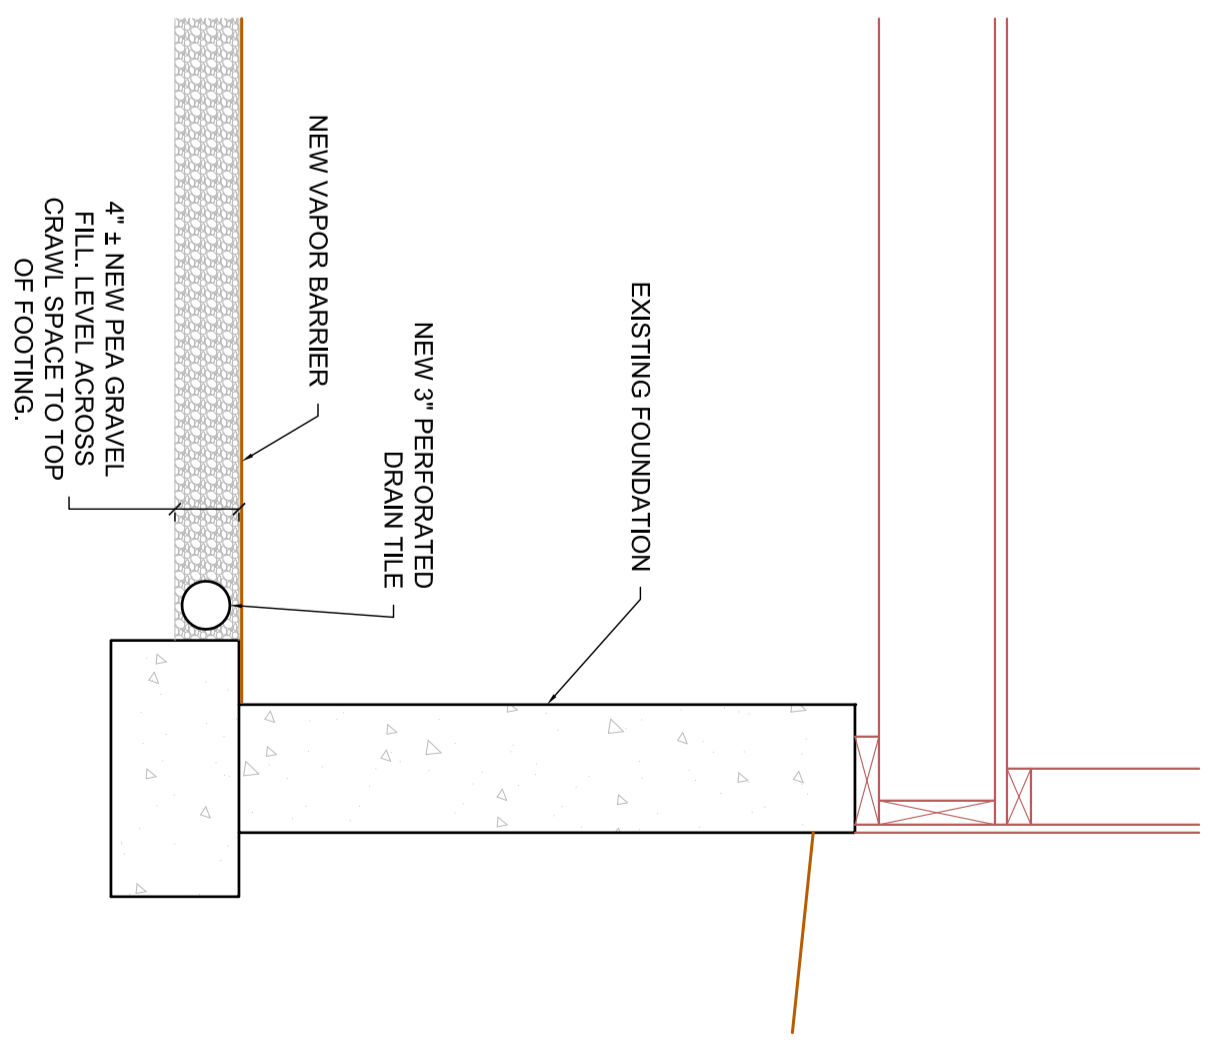

TYPICAL SECTION A/S1
 1" = 1'-0"

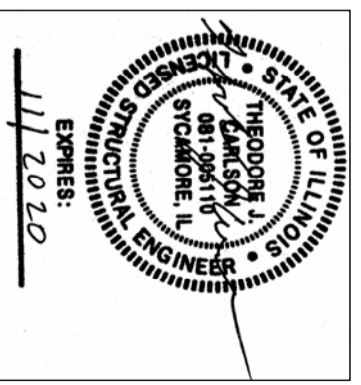

	BEAM REPLACEMENT DRAINAGE INSTALLATION 1108 NORTH MADISON STREET WOODSTOCK, IL	 STRUCTURAL DYNAMICS, INC PROF DESIGN #184.006780 P.O. BOX 507 SYCAMORE, IL 60178 PHONE: 815-899-2435	REVISION BY
DATE: 2-18-20 JOB: E2001 SCALE: NOTED DRAWN: TJC	DATE: 2-18-20 JOB: E2001 SCALE: NOTED DRAWN: TJC	DATE: 2-18-20 JOB: E2001 SCALE: NOTED DRAWN: TJC	DATE: 2-18-20 JOB: E2001 SCALE: NOTED DRAWN: TJC